


\\nas03.local\MSD\Projects\Private\Global Property Developers Corporation\Storm Drain\1000403_C-206\1000403_C-206.dwg Author: Parnell\JC102.dwg

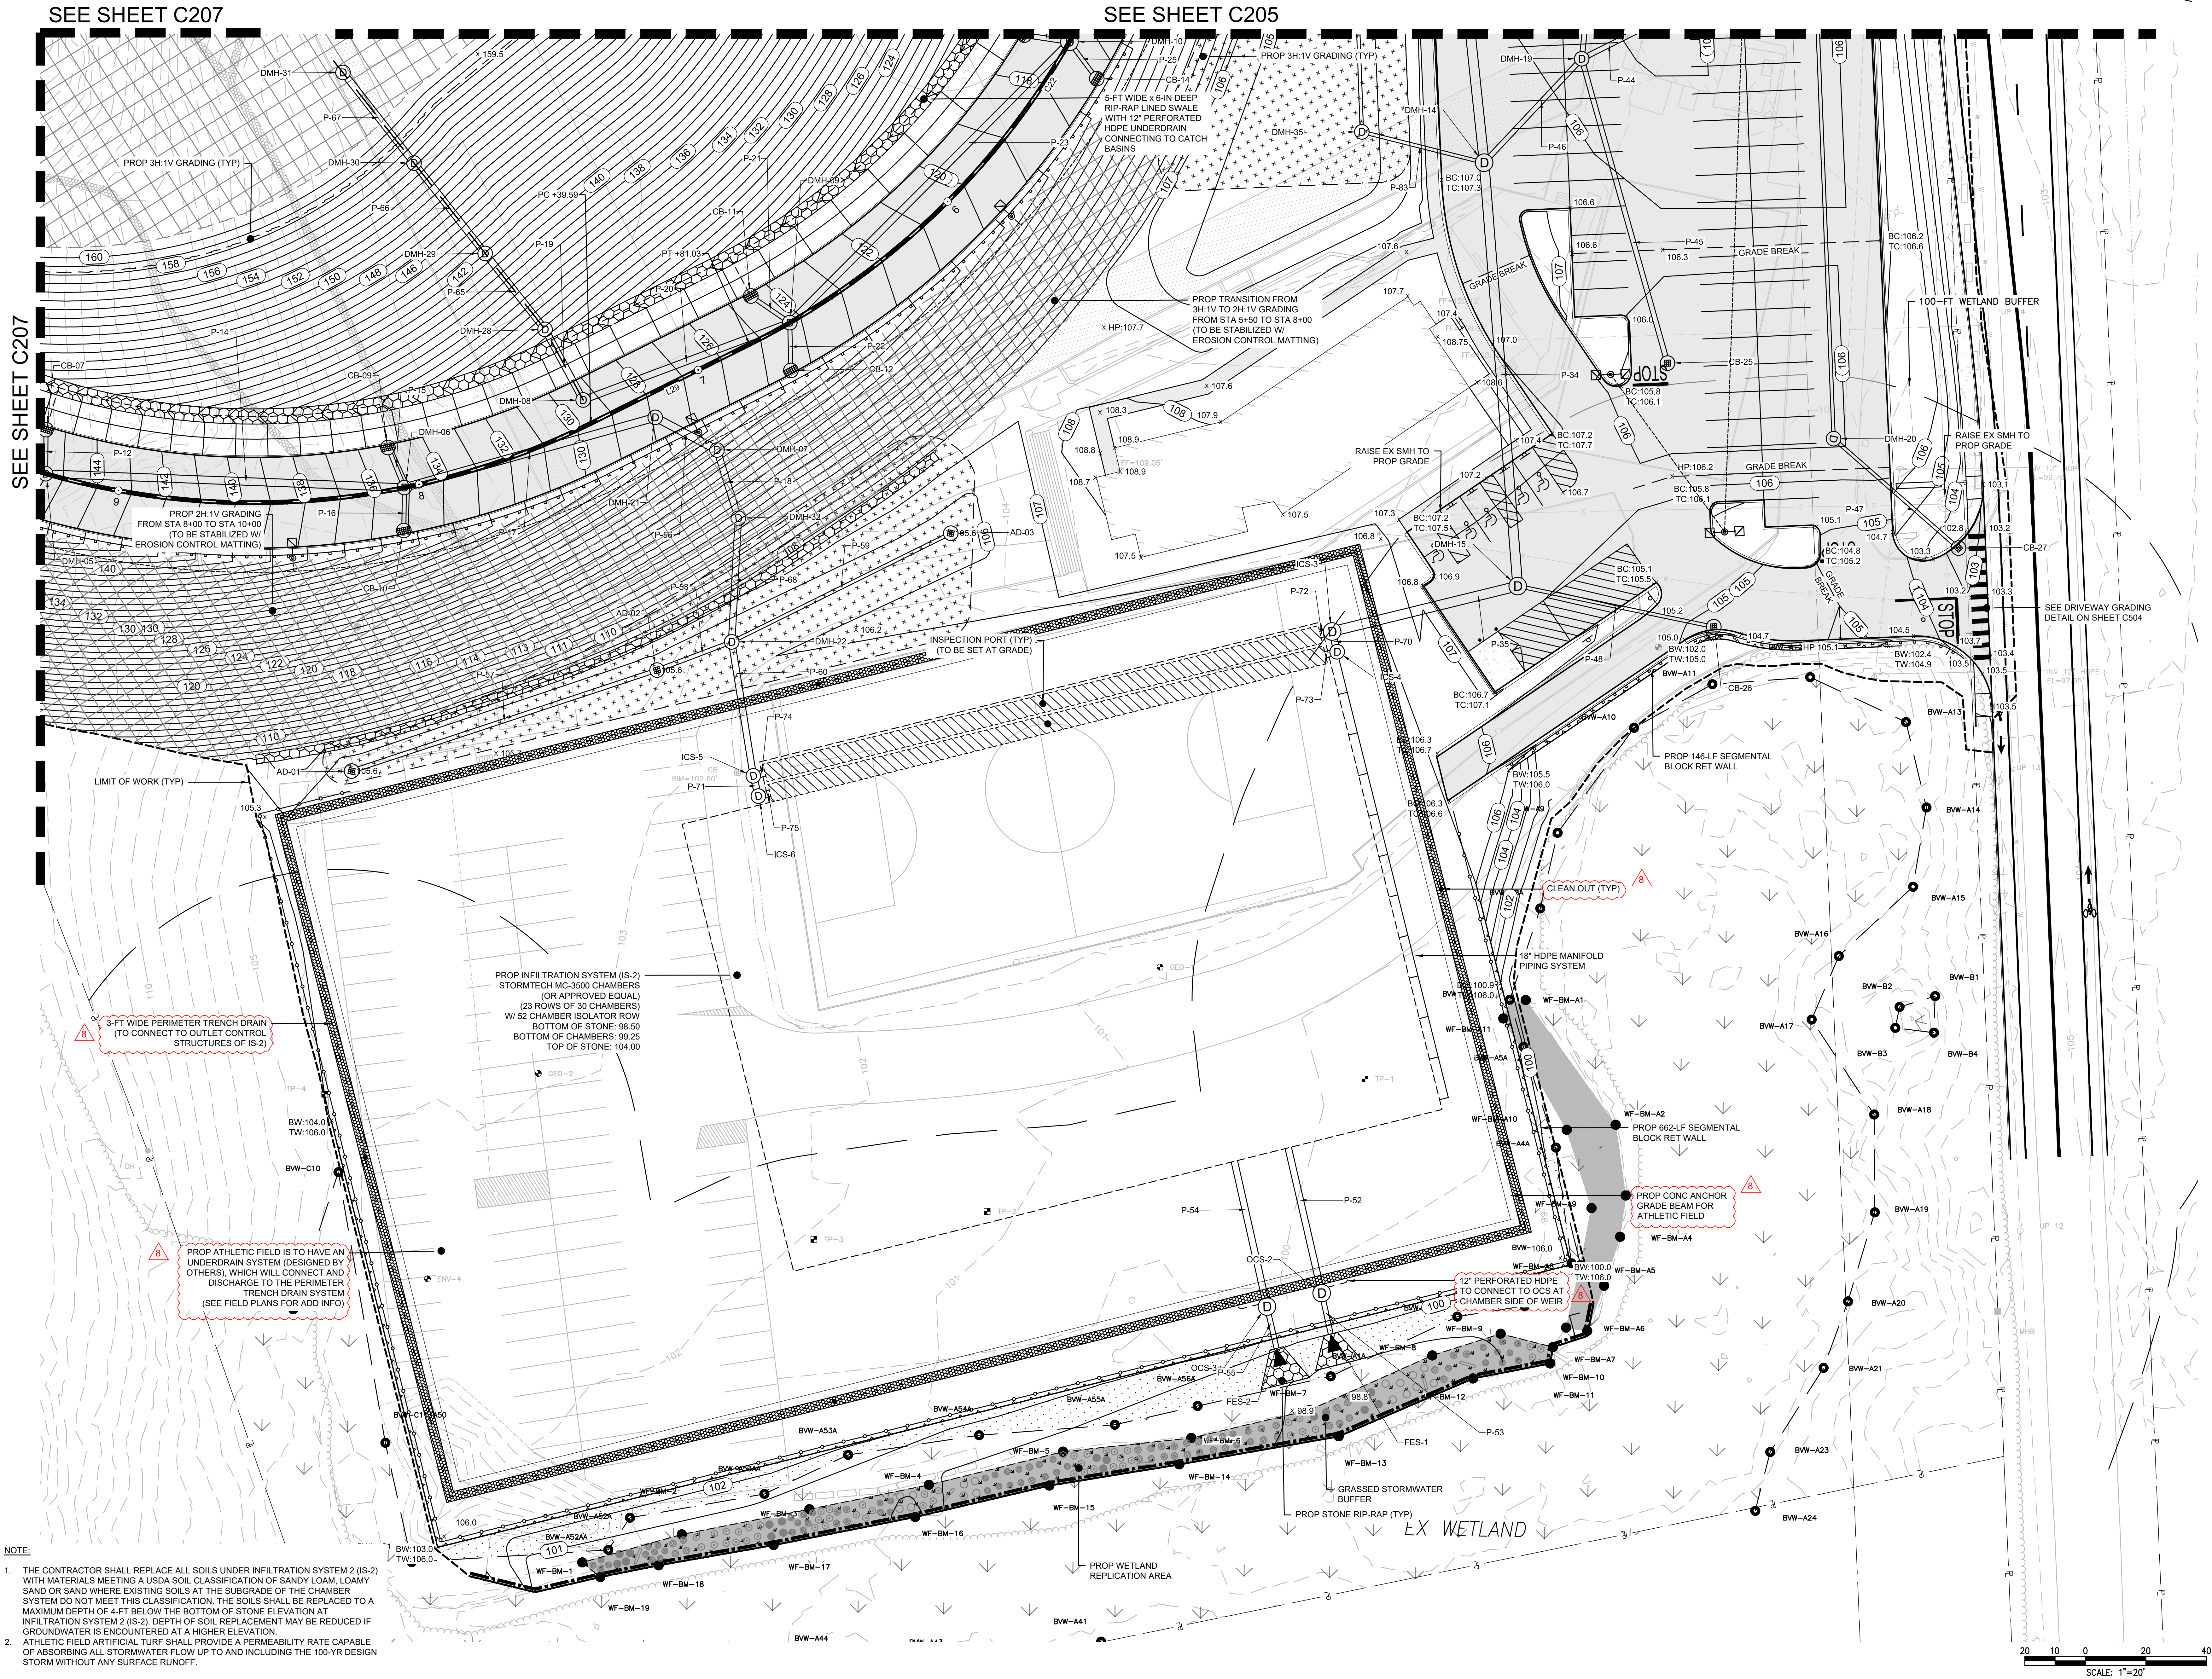

Project: AMESBURY SPORTS PARK
12-14 SOUTH HUNT ROAD
AMESBURY, MA 01913

Developer:
GLOBAL PROPERTY DEVELOPERS CORPORATION
80 1ST STREET
BRIDGEWATER, MA 02324

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Consultants:

Revisions:		
No.	Date	Description
1	10/16/20	PER PEER REVIEW
2	12/21/20	PER PEER REVIEW
3	01/15/21	PER PEER REVIEW
4	02/10/21	PER PEER REVIEW
5	02/15/21	PER PEER REVIEW
6	04/23/21	PER PEER REVIEW
7	06/23/21	PER PEER REVIEW
8	10/15/21	DESIGN MODIFICATION

Seal:
JAMES I. PEARSON
CIVIL
No. 50675
01/01/2021

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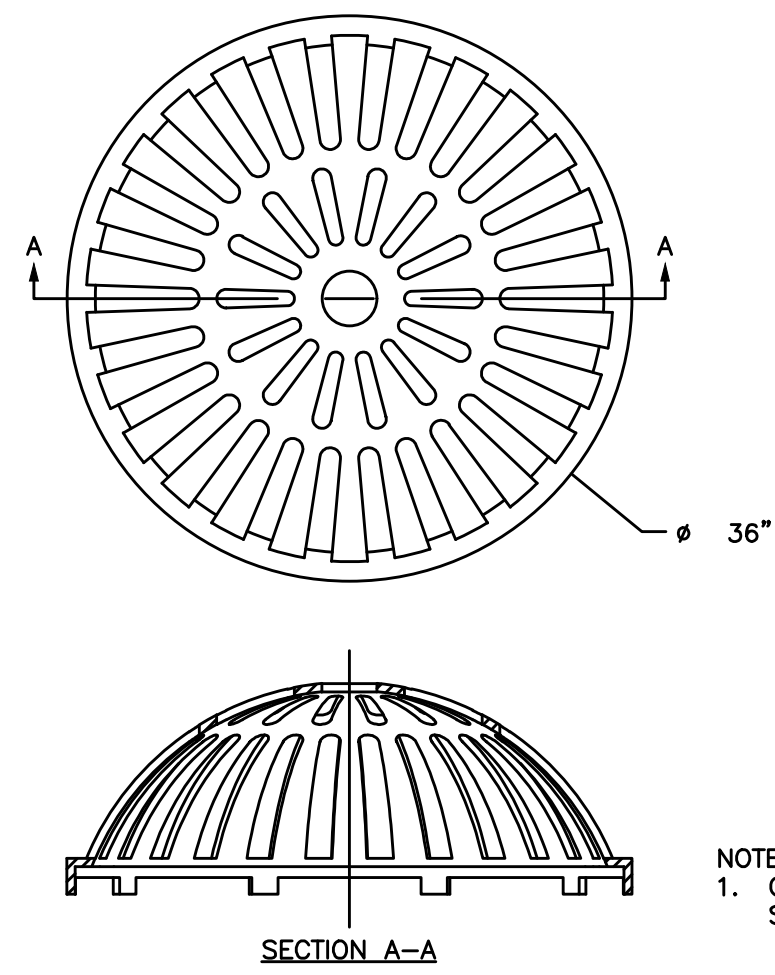
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Drawn By:	AKG
Reviewed By:	JJP
Approved By:	JJP
W&S Project No.:	2190336
W&S File No.:	


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ENLARGED
GRADING &
DRAINAGE PLAN

Sheet Number:
C206




NOTE:
1. GRATES ARE TO BE LOCATED AS SHOWN ON PLANS.

1 36" BEEHIVE DRAIN GRATE
SCALE: N.T.S.

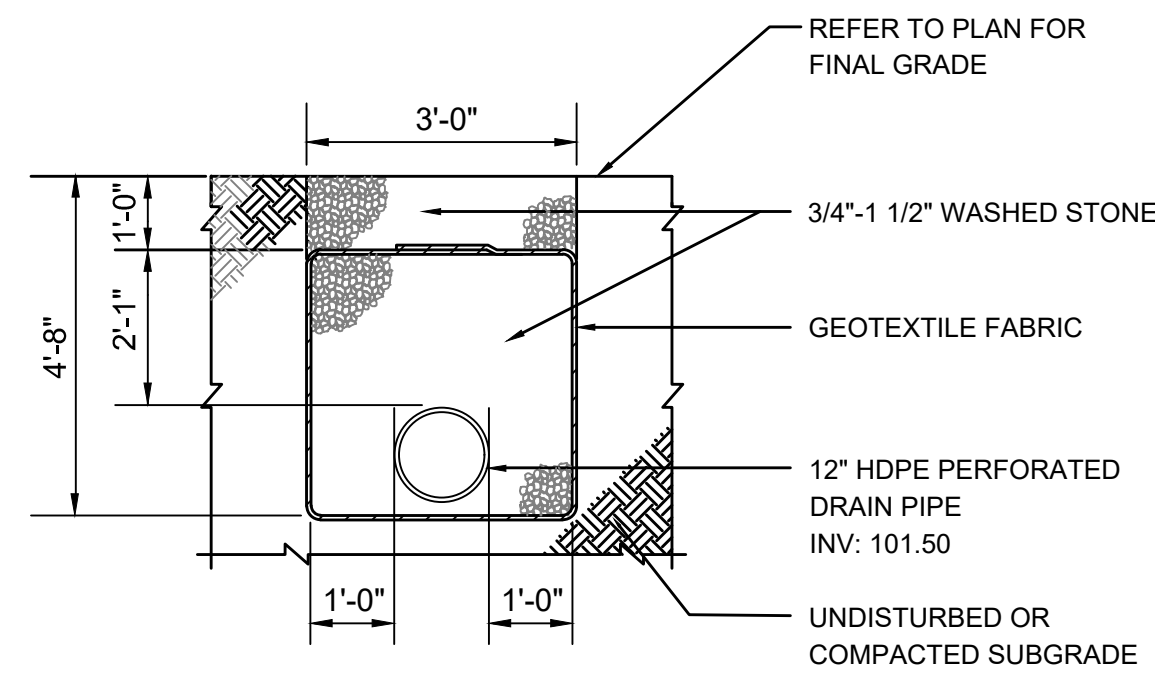


2 PERIMETER TRENCH DRAIN
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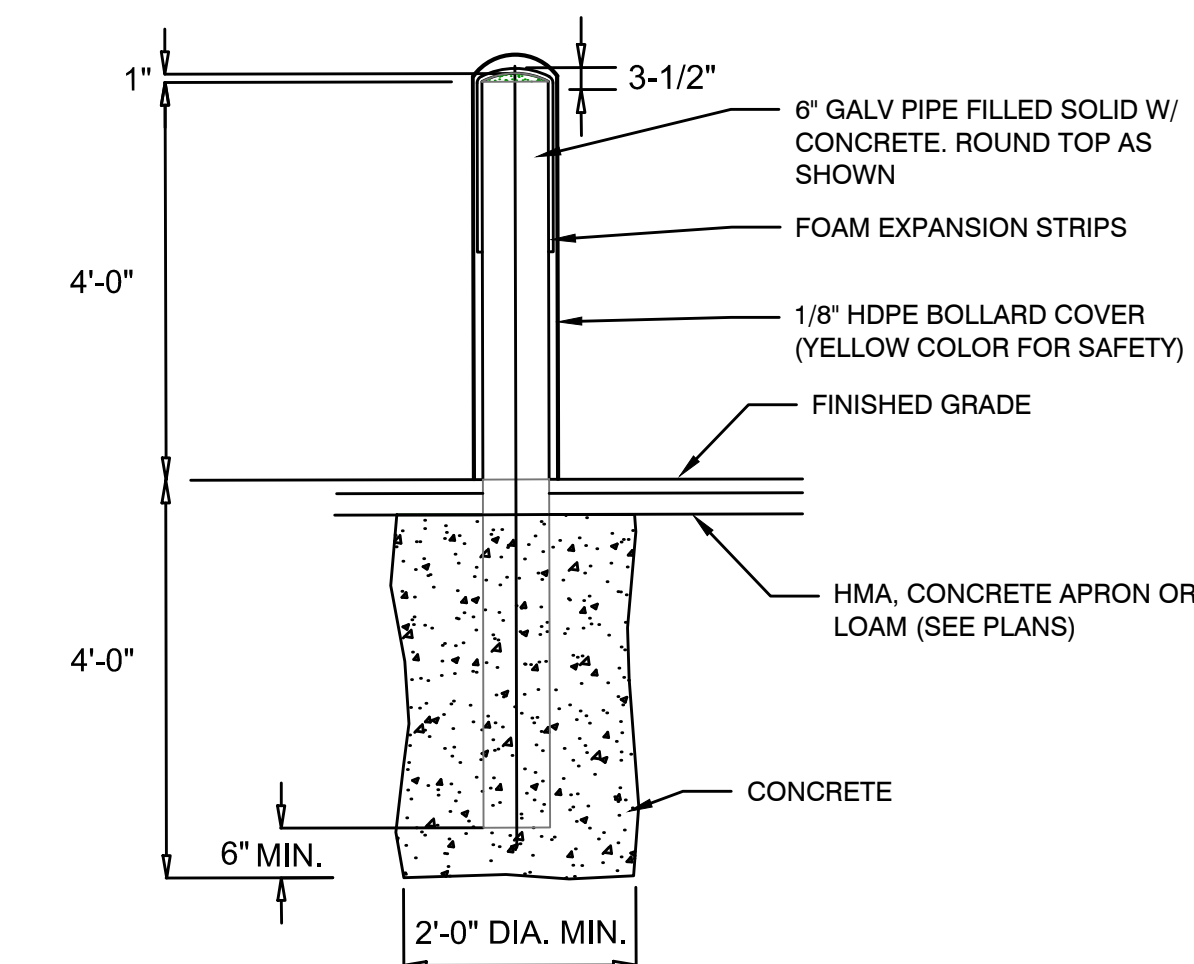
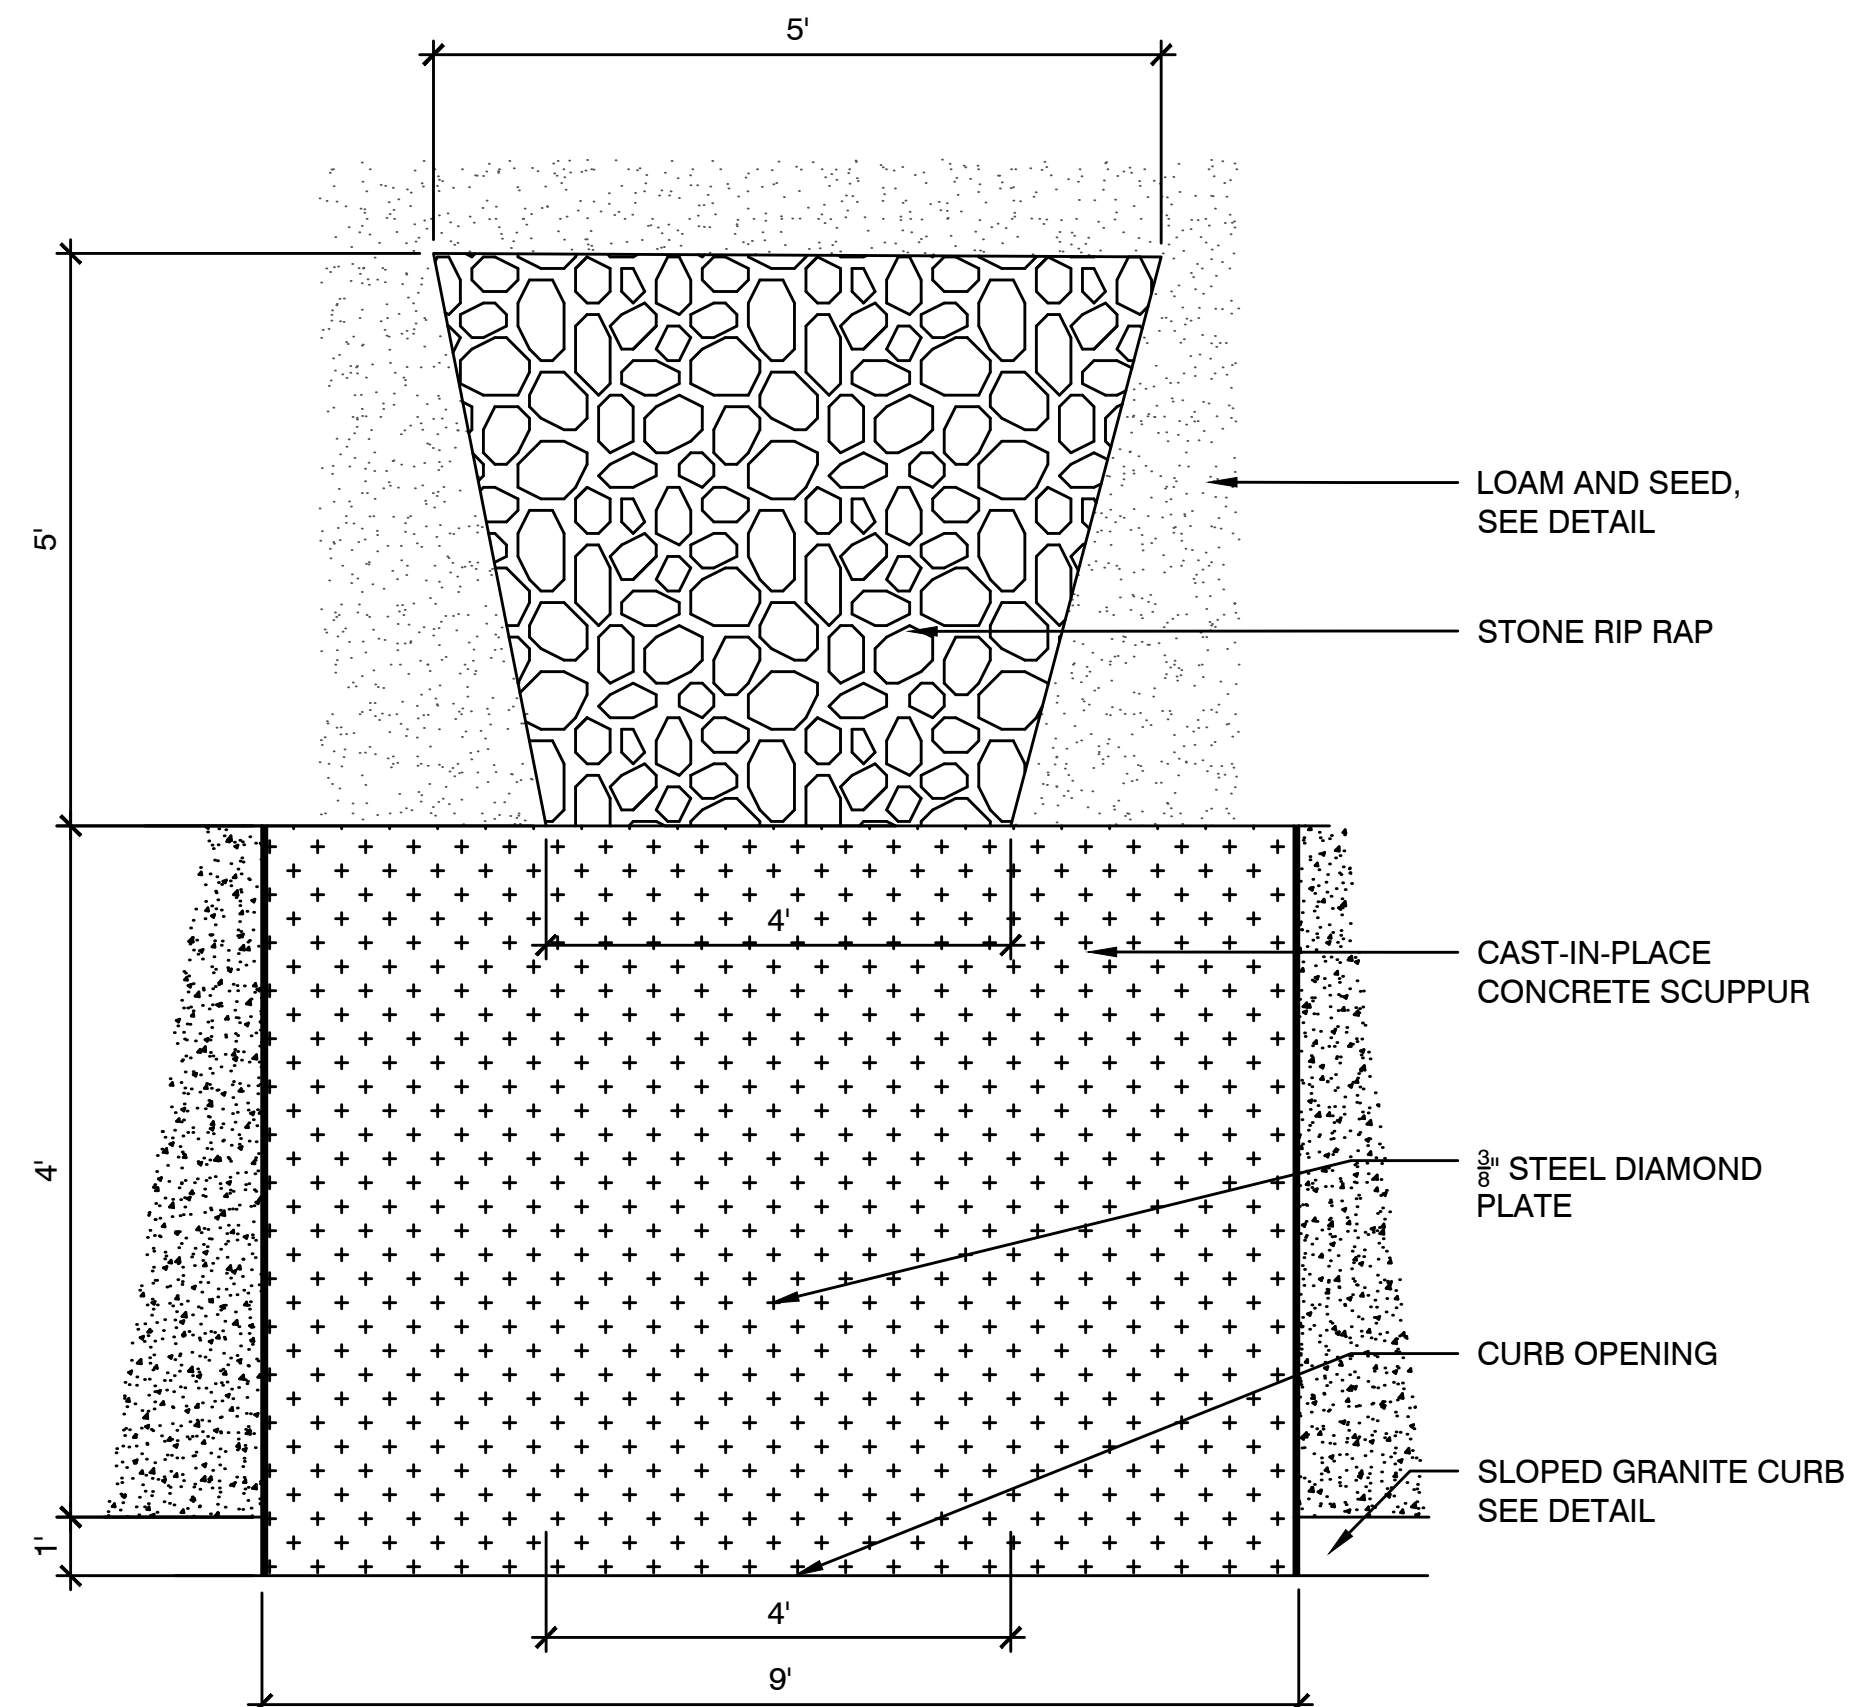


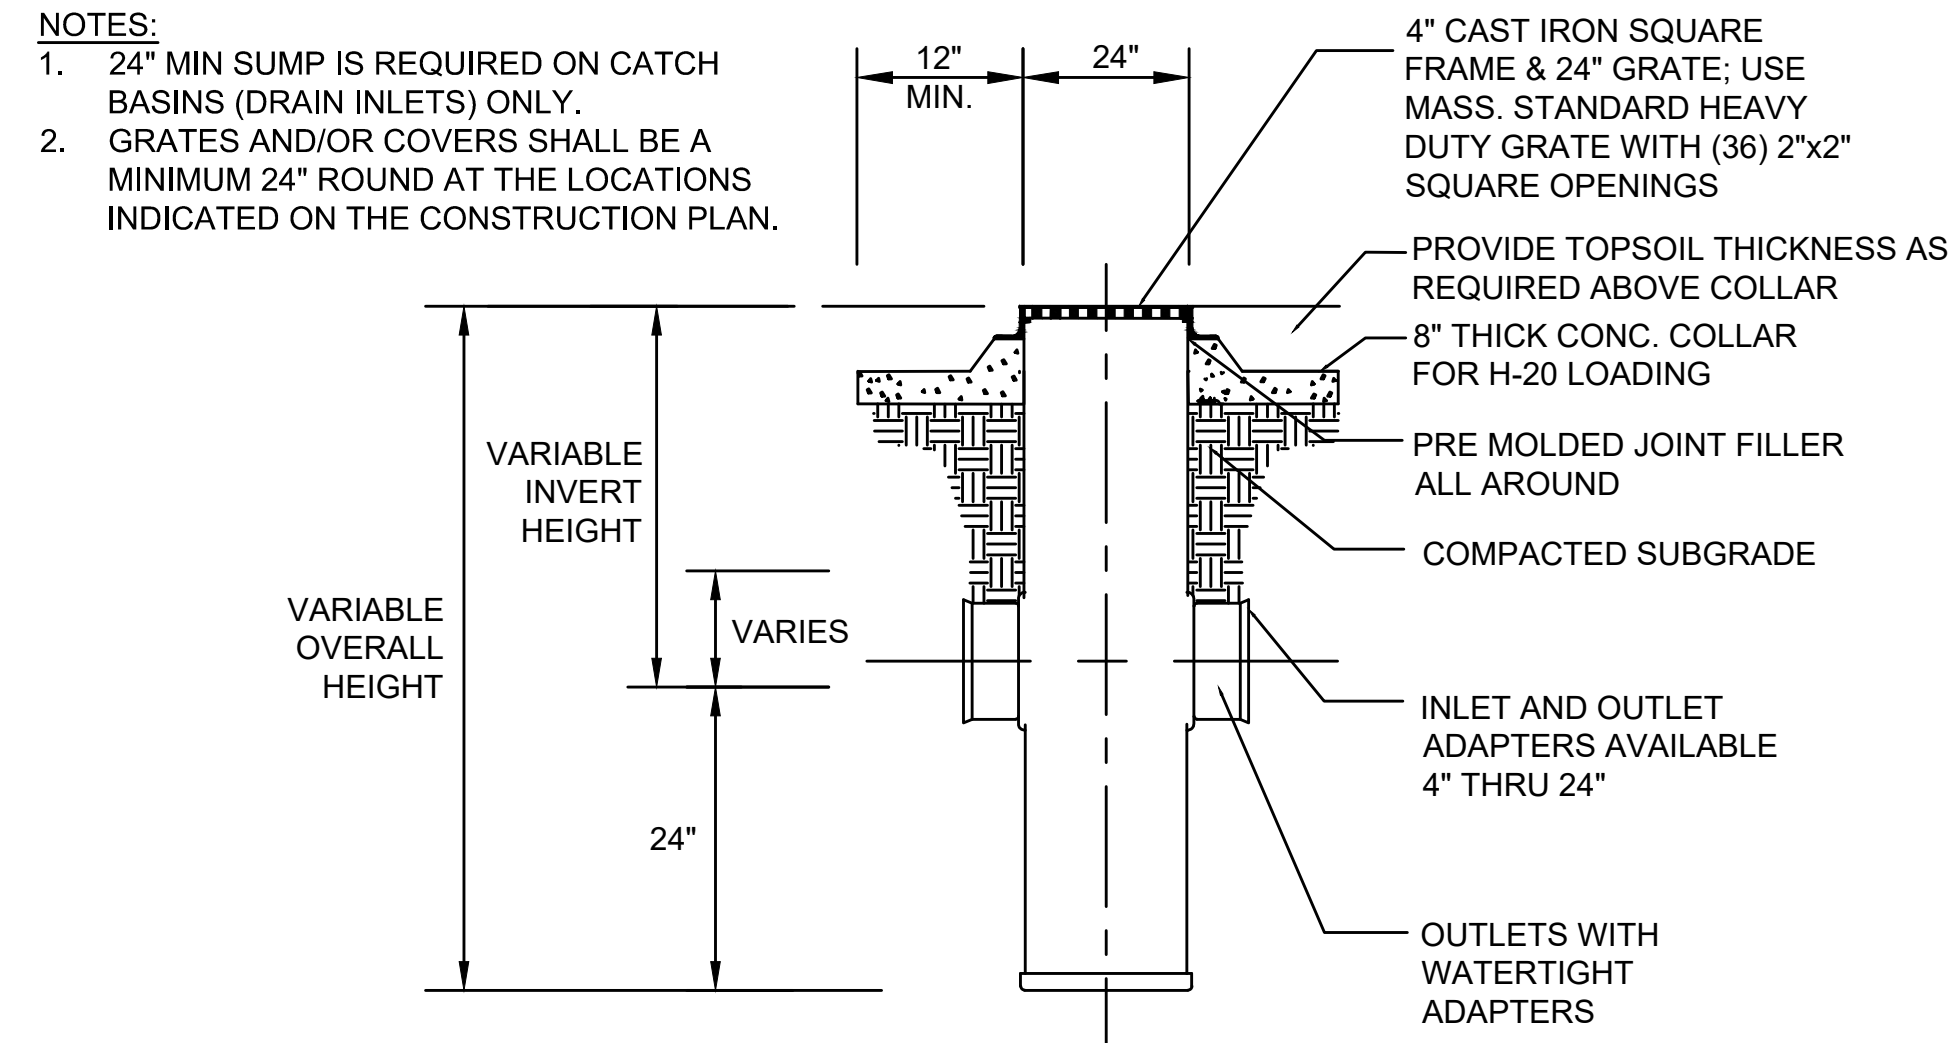NOTES:
1. 24" MIN SUMP IS REQUIRED ON CATCH BASINS (DRAIN INLETS) ONLY.
2. GRATES AND/OR COVERS SHALL BE A MINIMUM 24" ROUND AT THE LOCATIONS INDICATED ON THE CONSTRUCTION PLAN.

3 PVC AREA DRAIN
SCALE: N.T.S.

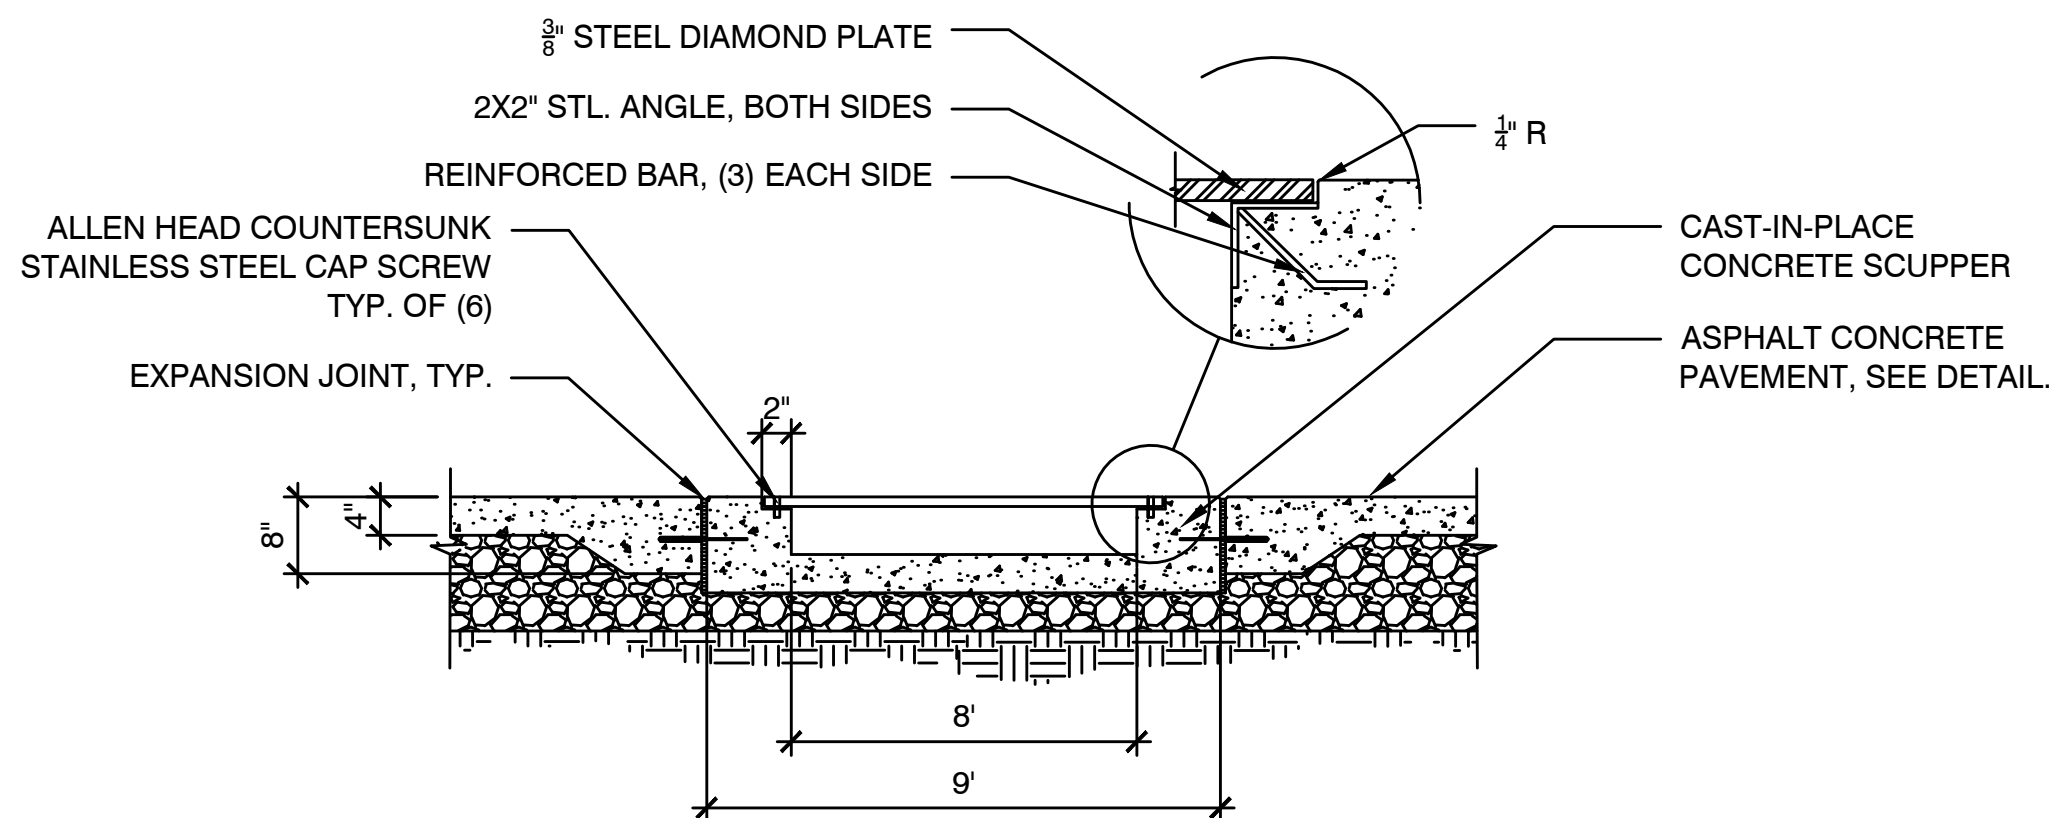

4 SIDEWALK SCUPPER
SCALE: N.T.S.



NOTES:
1. SEE PLANS FOR BOLLARD LOCATIONS.
2. BOLLARD FOUNDATION CONCRETE TO BE 3K PSI MIN.
3. EXACT LOCATION TO BE DETERMINED IN FIELD AND APPROVED BY OWNER PRIOR TO INSTALLATION.
4. 6" GALVANIZED PIPE TO BE PROVIDED BY MISC METALS CONTRACTOR. INSTALLATION AND CONCRETE BY GC.
5. HDPE BOLLARD SLEEVE WITH 6 7/8" DIAMETER TO BE INSTALLED OVER STEEL BOLLARD USING TWO FOAM EXPANSION STRIPS.

5 STEEL PIPE BOLLARD WITH HDPE SLEEVE
SCALE: N.T.S.

No.	Date	Description
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6	04/23/21	PER PEER REVIEW
7	06/23/21	PER PEER REVIEW
8	10/15/21	DESIGN MODIFICATION

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PROFESSIONAL ENGINEER
10/12/2021

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Drawn By: AKG
Reviewed By: JIP
Approved By: JIP
W&S Project No.: 2190336
W&S File No.:

Drawing Title:
CONSTRUCTION
DETAILS

Sheet Number:
C506